


ANTI-AIRCRAFT CREEK CULVERT REPLACEMENT CITY OF ISSAQUAH

CITY PROJECT NO: g02512

50% DESIGN REVIEW SUBMITTAL JANUARY 05, 2015

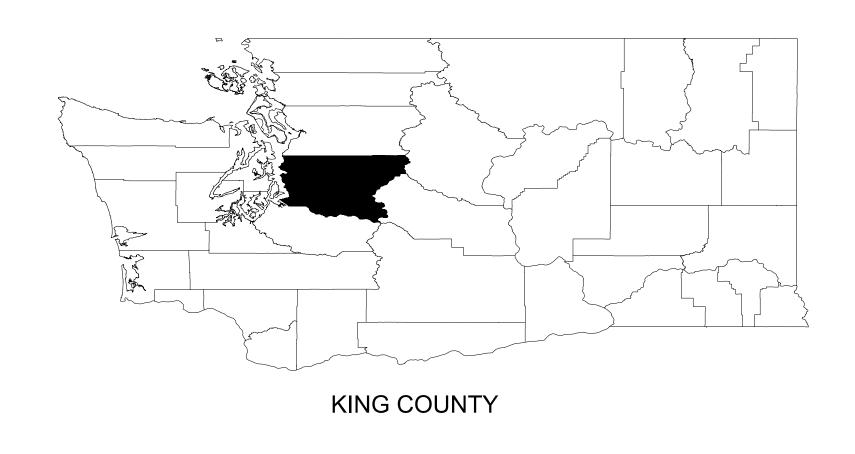

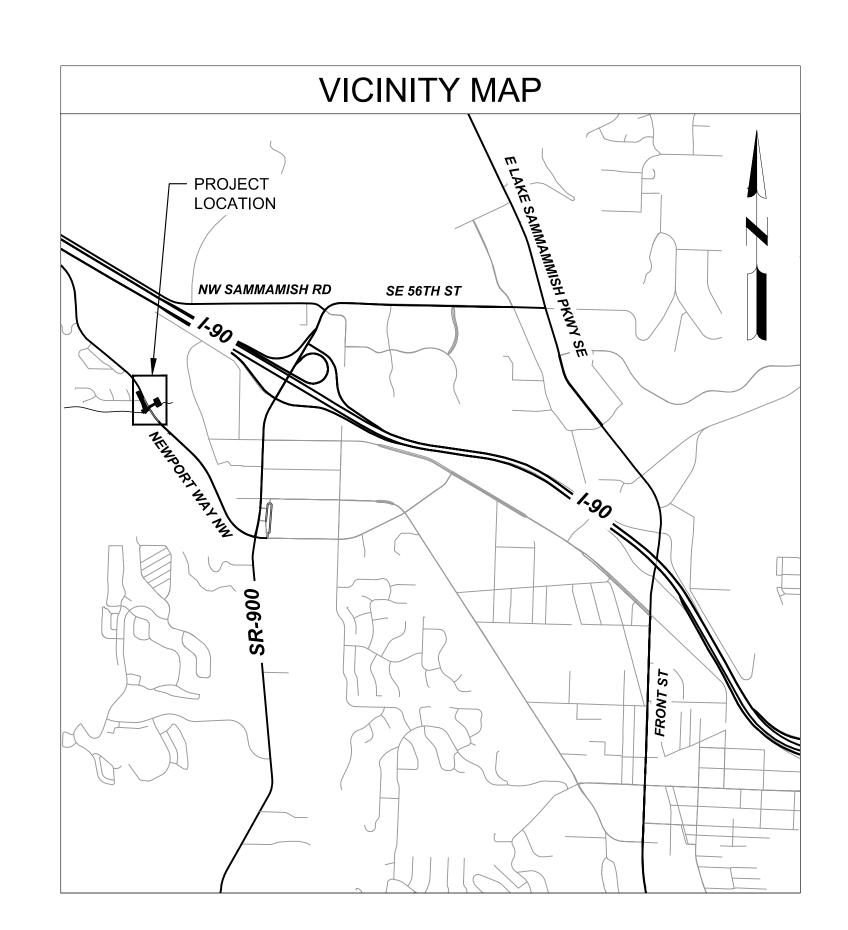

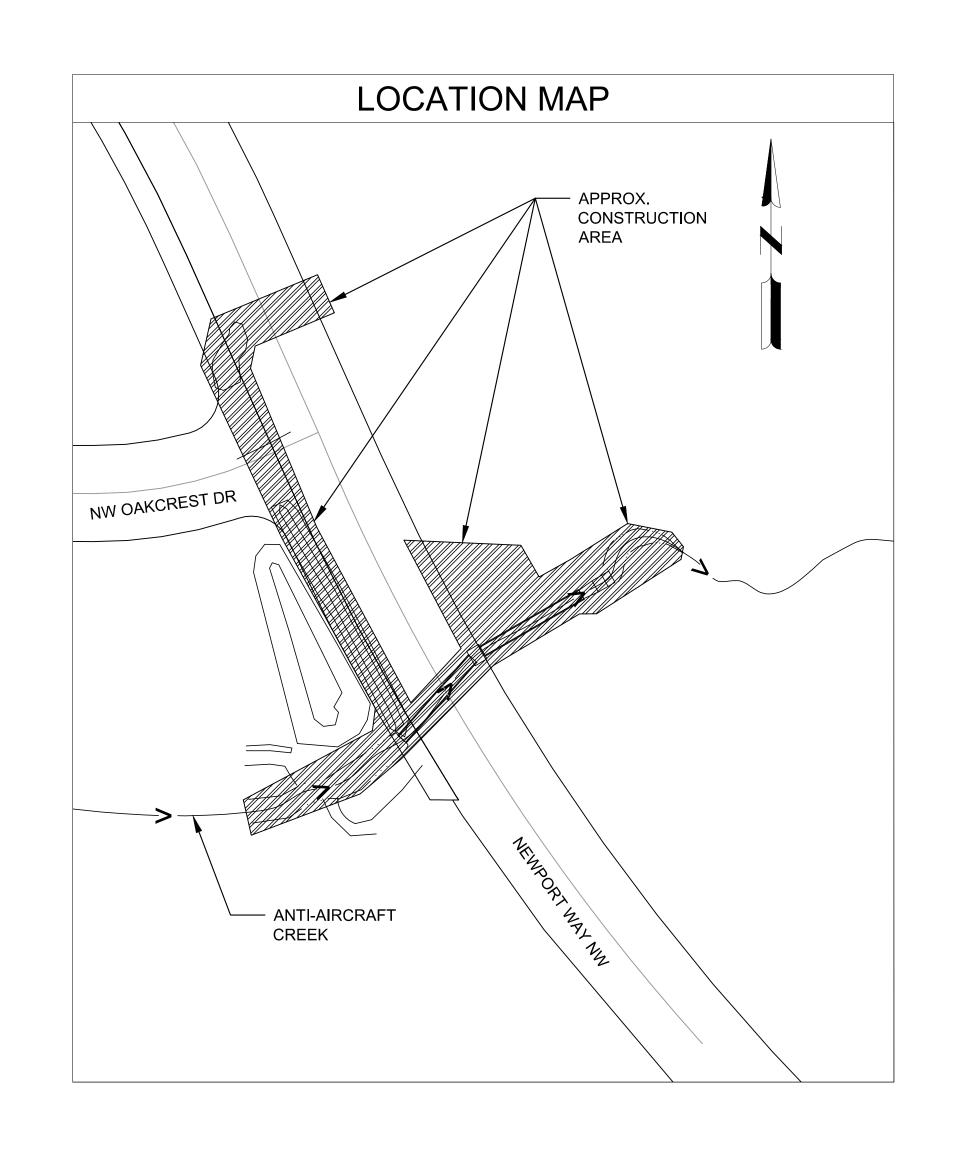

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CREEK CREEK CEMENT

NTI-AIRCRAFT CRESULVERT REPLACE

ISSUED

NOT FOR CONSTRUCTION

M&H NO.: 4134300-132044.

DATE: JANUARY 05, 20

DESIGNED BY: DKE

DRAWN BY: DKE

CHECKED BY: DAS/KF
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COVER SHEET

STANDARD TESC PLAN NOTES FOR CITY PROJECTS

1. TESC COORDINATION

- a. A CERTIFIED EROSION AND SEDIMENT CONTROL LEAD (CESCL) SHALL BE DESIGNATED BY THE CONTRACTOR AS THE PROJECT'S TESC SUPERVISOR AND SHALL BE RESPONSIBLE FOR THE PERFORMANCE, MAINTENANCE, AND REVIEW OF TESC MEASURES AND FOR COMPLIANCE WITH ALL PERMIT CONDITIONS RELATED TO TESC. THE TESC SUPERVISOR SHALL BE CERTIFIED BY THE DEPARTMENT OF ECOLOGY'S TRAINING REQUIREMENT.
- b. <u>CONTRACTOR'S REVISED TESC PLANS.</u> THE TESC MEASURES SHOWN ON THIS PLAN ARE THE MINIMUM REQUIREMENTS FOR ANTICIPATED SITE CONDITIONS. THE CONTRACTOR MAY REVISE THE TESC MEASURES SHOULD THEY DETERMINE THAT THERE IS A NEED TO BE MODIFIED TO COMPLY WITH THE PERMIT CONDITIONS OR IF THERE IS A MORE EFFECTIVE AND EFFICIENT WAY TO MEET THE PERFORMANCE OBJECTIVES FOR THE DURATION OF THE PROJECT.
- c. <u>IMPLEMENTING REVISED TESC PLANS.</u> THE CONTRACTOR SHALL CONSULT WITH THE CITY PRIOR TO IMPLEMENTING ANY CHANGES TO ENSURE COMPLIANCE WITH CITY PERMITS, THE CONTRACT, AND THAT THE CHANGES DO NOT NEGATIVELY IMPACT PROPERTY OR PUBLIC SAFETY.
- d. AN ONSITE TESC PRECONSTRUCTION MEETING SHALL BE HELD BEFORE ANY WORK BEGINS TO REVIEW IMPLEMENTATION OF THE

2. INITIAL TESC INSTALLATION

TESC PLANS AND REPORT.

- a. ALL TESC FACILITIES SHOWN ON THE PLANS SHALL BE INSTALLED PRIOR TO OR IN CONJUNCTION WITH ALL CLEARING AND GRADING SO AS TO ENSURE THAT THE SEDIMENT-LADEN WATER DOES NOT ENTER THE CITY DRAINAGE SYSTEM, SURFACE WATERS, OR WETLANDS. ADJACENT PROPERTIES SHALL BE PROTECTED FROM SEDIMENT-LADEN RUNOFF. IF NOT SPECIFICALLY SHOWN ON THE PLANS OR THE TESC REPORT, INSTALLATION SHALL BE DONE IN ACCORDANCE WITH APPENDIX D OF THE KING COUNTY SURFACE WATER DESIGN MANUAL, "EROSION AND SEDIMENT CONTROL STANDARDS", OR AS DIRECTED BY THE CITY.
- b. <u>CLEARING LIMITS AND TREE PROTECTION</u> BOUNDARIES SHOWN ON THE PLANS SHALL BE CLEARLY FLAGGED BY SURVEY TAPE OR FENCING PRIOR TO CONSTRUCTION. NO DISTURBANCE BEYOND THE CLEARING LIMITS IS ALLOWED.
- c. STABILIZED CONSTRUCTION ENTRANCES SHOWN ON THE PLANS SHALL BE INSTALLED AT THE BEGINNING OF CONSTRUCTION AND MAINTAINED FOR THE DURATION OF THE PROJECT. ONSITE ROADS AND PAVED AREAS SHALL BE KEPT CLEAN TO MINIMIZE TURBIDITY IN RUNOFF. ADDITIONAL MEASURES, SUCH AS CONSTRUCTED WHEEL WASH SYSTEMS OR WASH PADS, IF SHOWN ON THE PLANS, ARE REQUIRED TO ENSURE SEDIMENT IS NOT TRACKED OUT TO CITY STREETS. ANY DIRT TRACKED ONTO CITY STREETS SHALL BE SWEPT AS NEEDED OR AS DIRECTED BY THE CITY OF ISSAQUAH. STREET SWEEPING IS NOT CONSIDERED A TESC MEASURE.
- d. <u>COVERING OF EXPOSED SOILS</u>, INCLUDING ROADWAY EMBANKMENTS, THAT WILL NOT BE DISTURBED FOR TWO CONSECUTIVE DAYS DURING THE WET SEASON (OCT 1 TO APRIL 30) OR SEVEN DAYS DURING THE DRY SEASON (MAY 1 TO SEPT 30) SHALL BE DONE USING APPROVED TESC METHODS (E.G. SEEDING, MULCHING, PLASTIC COVERING, ETC.). THESE TIME LIMITS MAY BE MODIFIED BY THE CITY TO ADDRESS SPECIFIC SITE AND WEATHER CONDITIONS.
- e. <u>COLLECTION AND TREATMENT OF RUNOFF</u> USING DITCHES, SWALES, OR PIPES IS REQUIRED TO ROUTE STORMWATER TO COLLECTION POINTS WHERE IT IS TREATED PRIOR TO INFILTRATION OR DISCHARGE OFFSITE. WHEN SHOWN ON THE PLANS, TEMPORARY STORAGE FACILITIES SUCH AS PONDS AND TANKS SHALL BE INSTALLED AT THE ONSET OF CONSTRUCTION, REGARDLESS OF THE TIME OF YEAR.
- f. <u>DISCHARGE TO THE SANITARY SEWER</u> IS ALLOWED UPON APPROVAL FROM THE CITY OR SAMMAMISH PLATEAU WATER AND SEWER DISTRICT AND THE KING COUNTY INDUSTRIAL WASTE PROGRAM. PRETREATMENT PRIOR TO DISCHARGE IS REQUIRED TO MEET COUNTY OR SEWER DISTRICT STANDARDS.
- g. <u>WORKING IN STREAMS.</u> ALL IN-WATER WORK WITHIN WATERS OF THE STATE SHALL BE CONDUCTED DURING THE HPA-SPECIFIED FISH WINDOW. ANY EQUIPMENT WORKING WITHIN REGULATED WATERS SHALL BE EQUIPPED WITH VEGETABLE-BASED (NON-TOXIC) HYDRAULIC FLUIDS, AND APPROPRIATE METHODS SHALL BE EMPLOYED TO DIVERT THE STREAM AROUND THE WORKING AREA OR ISOLATE THE WORKING AREA FROM THE STREAM USING BARRIERS.

3. ROUTINE TESC MAINTENANCE

25 NTUS AND SHALL BE READILY AVAILABLE AT THE PROJECT SITE.

- a. MAINTENANCE OVER DURATION OF PROJECT. ALL TESC MEASURES SHALL BE MAINTAINED BY THE TESC SUPERVISOR FOR THE DURATION OF CONSTRUCTION, UNTIL FINAL LANDSCAPING OR OTHER PERMANENT SITE STABILIZATION IS COMPLETE
- b. <u>ROUTINE INSPECTIONS.</u> THE TESC FACILITIES SHALL BE INSPECTED BY THE TESC SUPERVISOR DAILY OR MORE OFTEN DURING RAINFALL, AND MAINTAINED TO ENSURE PROPER FUNCTIONING. WRITTEN DOCUMENTATION IS REQUIRED FOR DISCHARGES ABOVE
- c. OFFSITE PUMPING. THE TESC SUPERVISOR SHALL NOTIFY THE CITY OF ISSAQUAH PRIOR TO PUMPING ANY DISCHARGE OFFSITE OR TO CRITICAL AREAS.
- d. <u>INACTIVE SITES</u>. TESC FACILITIES ON INACTIVE SITES SHALL BE INSPECTED AND MAINTAINED A MINIMUM OF ONCE A MONTH OR WITHIN 24 HOURS FOLLOWING A STORM EVENT.
- e. <u>PREPARATION FOR WET SEASON</u>. PRIOR TO THE BEGINNING OF THE WET SEASON (OCT 1), ALL DISTURBED AREAS SHALL BE REVIEWED TO IDENTIFY WHICH ONES CAN BE SEEDED OR OTHERWISE COVERED IN PREPARATION FOR THE WINTER RAINS. IF COVER MEASURES ARE NOT ESTABLISHED BY OCT 1, ADDITIONAL TESC MEASURES SHALL BE REQUIRED.

4. TURBIDITY MONITORII

- a. MONITORING RESPONSIBILITY. THE CITY'S INSPECTOR WILL MEASURE THE TURBIDITY OF STORMWATER LEAVING THE SITE AT THE DESIGNATED MONITORING POINT(S) TO VERIFY COMPLIANCE WITH TURBIDITY DISCHARGE LIMITS THAT ARE SPECIFIED BELOW.
- b. MONITORING LOCATION. THE TURBIDITY MONITORING LOCATION, WHERE THE INSPECTOR WILL MEASURE TURBIDITY FOR COMPLIANCE, IS SHOWN ON THE TESC PLANS. FOR PROJECT SITES WHERE DESIGNATING A MONITORING POINT IS NOT FEASIBLE (E.G. FLAT SITES OR LINEAR UTILITY PROJECTS), THE MONITORING LOCATIONS WILL BE AT THE DISCRETION OF THE INSPECTOR.
- c. <u>25 NTU ACTION LEVEL</u>. THE TESC SUPERVISOR SHALL BE NOTIFIED OF DISCHARGES ABOVE 25 NTUS. THE TESC SUPERVISOR SHALL REVIEW AND MODIFY THE TESC MEASURES AS NEEDED TO KEEP DISCHARGES FROM THE SITE BELOW 25 NTUS.
- d. 100 NTU DISCHARGE LIMIT. THE CONTRACTOR IS RESPONSIBLE FOR INSTALLING AND MAINTAINING TESC MEASURES SO THAT DISCHARGE FROM THE PROJECT SITE SHALL NOT EXCEED 100 NTUS AT ALL TIMES UP TO THE 10 YEAR/24 HOUR STORM EVENT. THIS EVENT IS DEFINED AS 3.5 INCHES OF RAINFALL OVER A 24 HOUR PERIOD.

5. OTHER POLLUTION CONTROL MEASURES

- a. <u>POLLUTION CONTROL</u>. THE CONTRACTOR SHALL IMPLEMENT ALL REQUIREMENTS OF THE TESC REPORT AND STORMWATER POLLUTION PREVENTION PLAN, INCLUDING STORAGE AND HANDLING OF HAZARDOUS MATERIALS, CONCRETE HANDLING AND WASTEWATER DISPOSAL, SPILL KITS AND SPILL RESPONSE, AND OTHER MEASURES AS NEEDED.
- b. <u>CONTROL OF PROCESS WATER</u>. THE CONTRACTOR SHALL USE THE APPROPRIATE POLLUTION CONTROL MEASURES TO ENSURE THAT NO LIQUID PRODUCTS OR CONTAMINATED WATER SUCH AS RUNOFF FROM CONCRETE SLURRY (KNOWN AS PROCESS WATER) ENTERS THE STORM DRAINAGE SYSTEM, SURFACE WATERS, OR OTHERWISE LEAVES THE PROJECT SITE.

6. FINAL SITE STABILIZATION

- a. <u>FINAL STABILIZATION</u>. THE CONTRACTOR SHALL INSTALL ALL TESC NEEDED FOR FINAL STABILIZATION AT COMPLETION OF FINISH GRADING. THIS SHALL BE DONE WITHIN TWO CONSECUTIVE DAYS DURING THE WET SEASON (OCT 1 TO APRIL 30), SEVEN DAYS DURING THE DRY SEASON (MAY 1 TO SEPT 30) OR AS DIRECTED BY THE CITY.
- b. <u>REMOVAL OF TESC FACILITIES</u>. THE CONTACTOR SHALL REMOVE ALL TESC FACILITIES, EXCEPT THOSE THAT WILL REMAIN (SUCH AS SEED AND MULCH) AFTER FINAL STABILIZATION OF THE SITE.

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CITY OF ISSAQUAH
ANTI-AIRCRAFT CREEK
CULVERT REPLACEMENT

NOT FOR CONSTRUCTION

M&H NO.: 4134300-132044.01
DATE: JANUARY 05, 2015
DESIGNED BY: DKE
DRAWN BY: DKE

CHECKED BY: DAS/KF


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SHEET CONTENTS

SHEET NO. 2 of 10

NOTE SHEET

c nn2

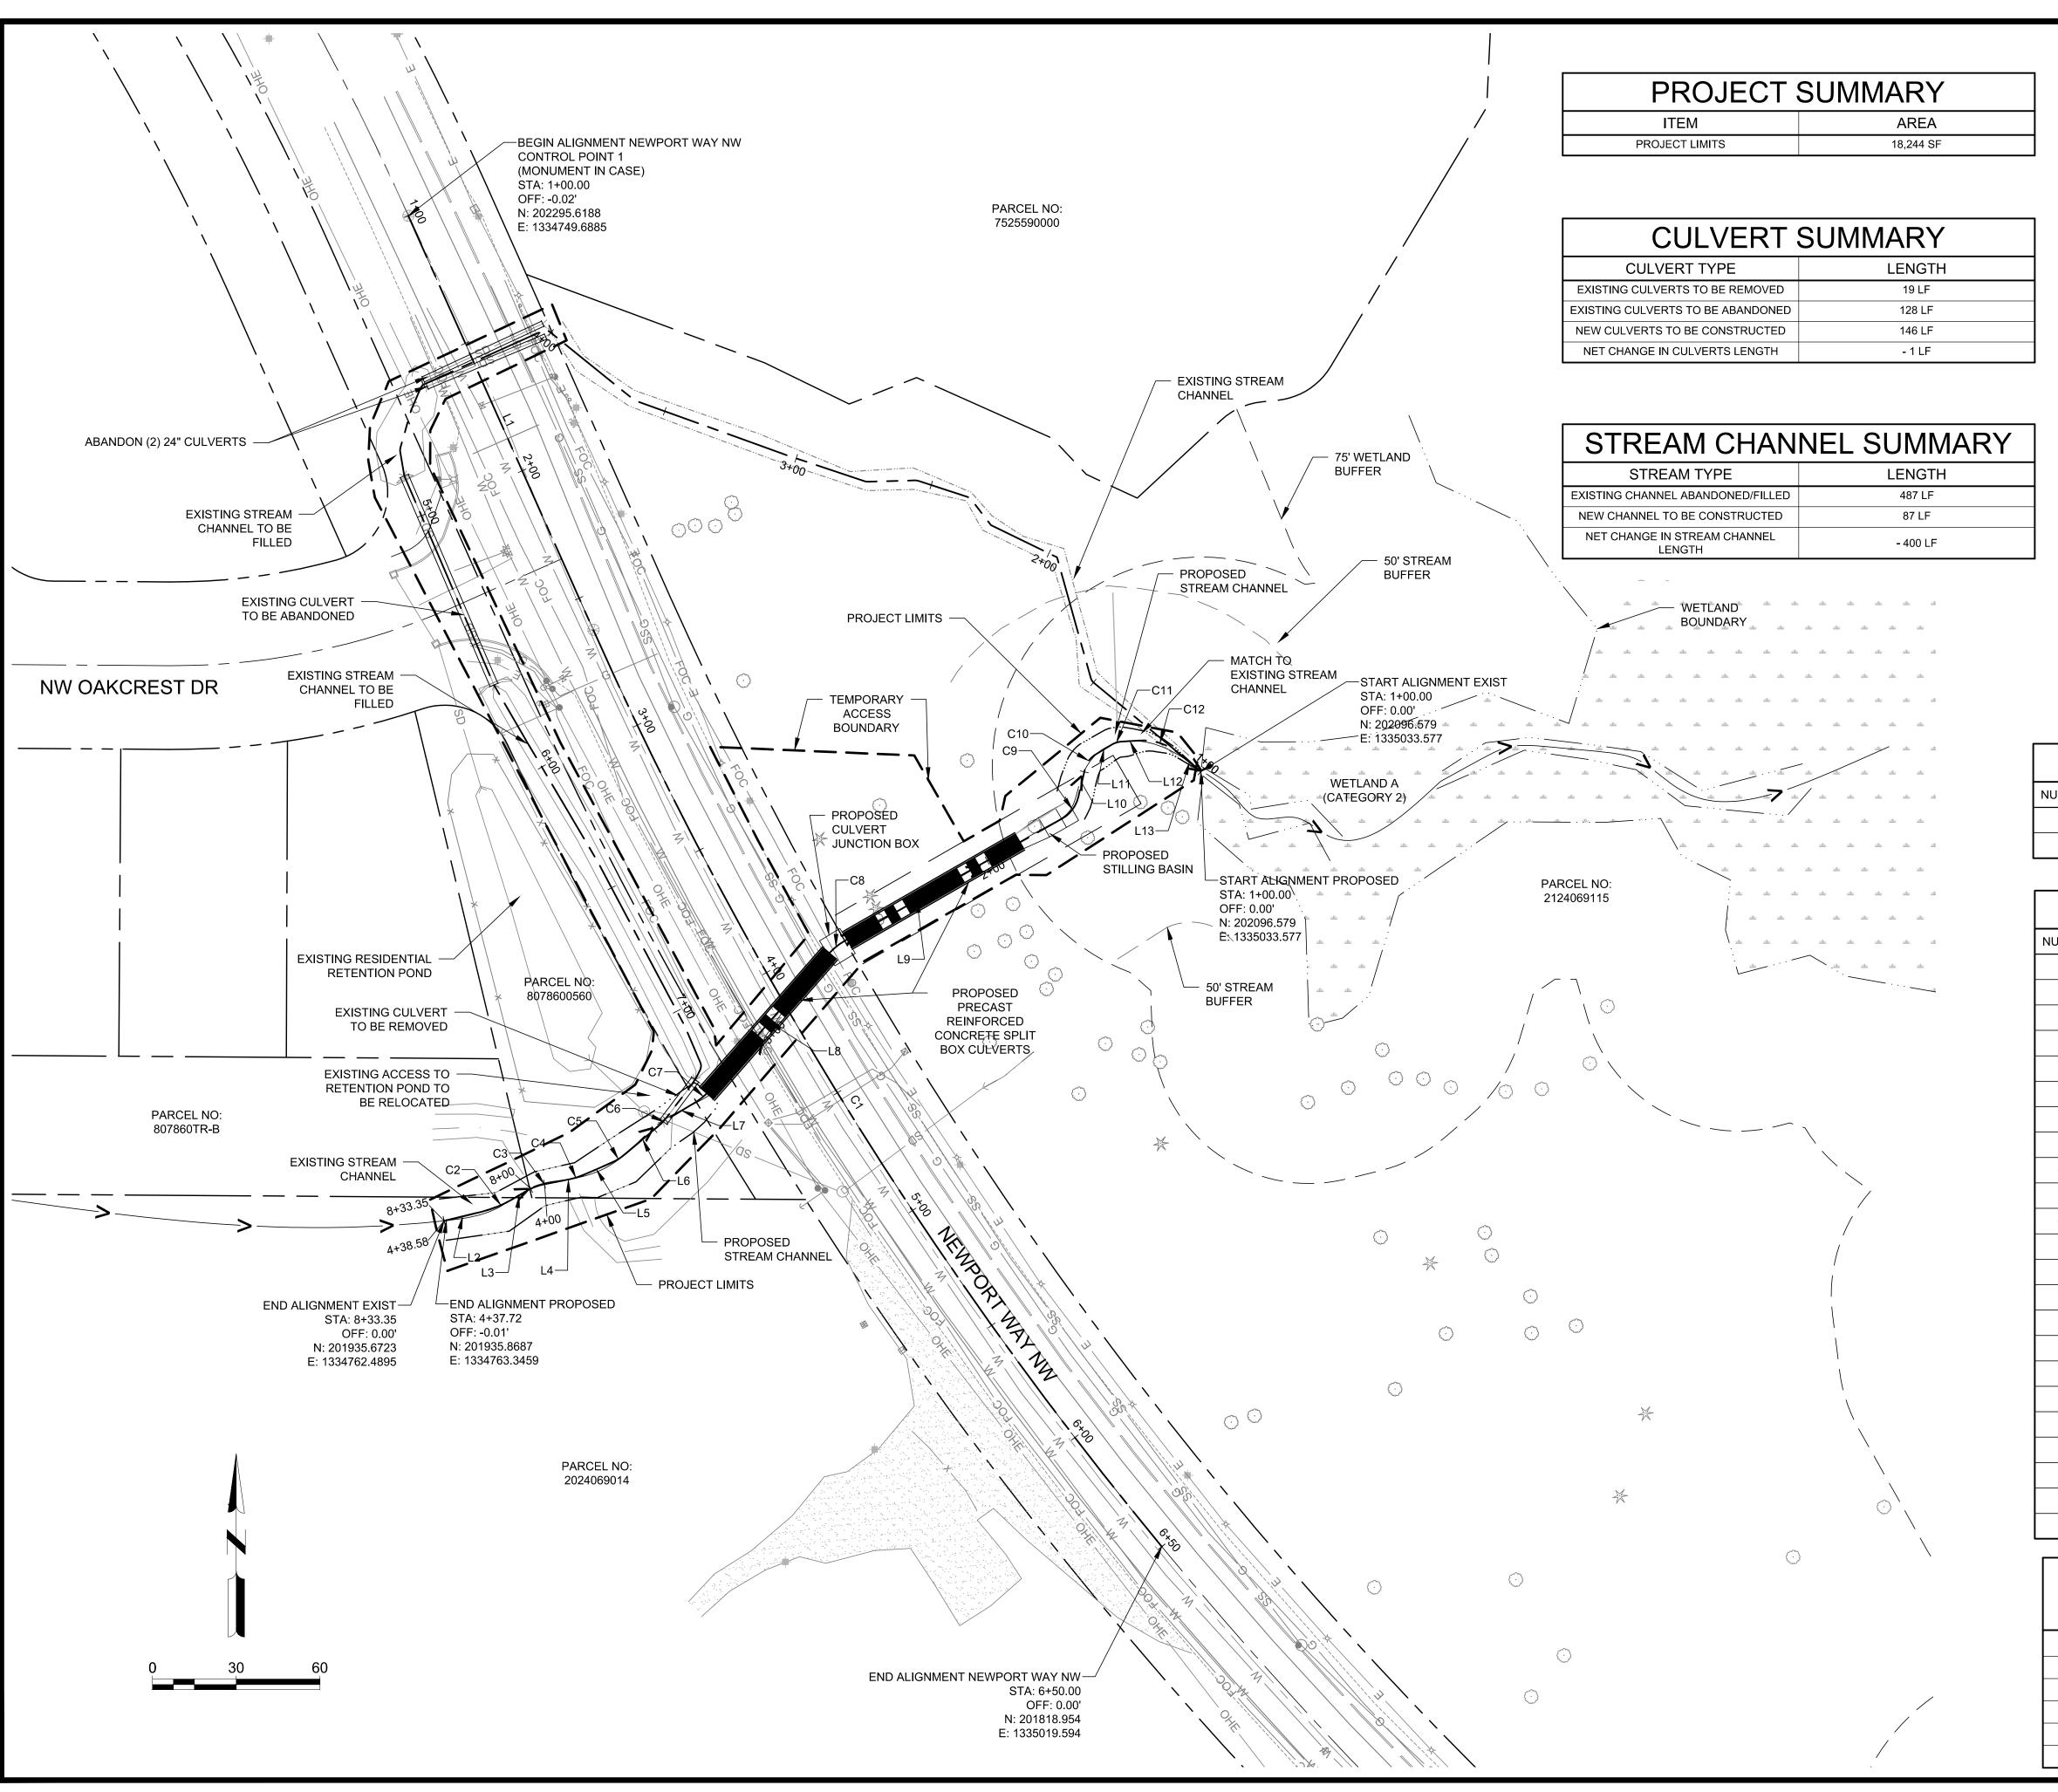

LEGEND

•	POWER/UTILITY POLE
T/S	TRAFFIC SIGNAL BOX
•-×	LUMINAIRE
←——	GUY ANCHOR
-	AREA LIGHT
•	BOLLARD
M	WATER VALVE
Œ	WATER METER
α	FIRE HYDRANT
Ф	HOSE BIB
ш	COMMUNICATION PEDESTAL
+	TRAFFIC SIGN
ss	SANITARY SEWER LINE
W	WATER LINE
SD	STORM DRAIN LINE
G	GAS LINE
——— OHE ———	OVERHEAD POWER LINE
FOC	COMMUNICATION/FIBER OPTIC LINE
0 0 0 00	GUARD RAIL

UNDERGROUND POWER

PROJECT LIMIT

HORIZONTAL CONTROL

NEWPORT WAY NW						
NUMBER	LENGTH	RADIUS	LINE / CHORD DIRECTION	A VALUE		
C1	387.361	1432.690	SOUTH31° 48' 54.29"EAST			
L1	162.640		S24° 04' 10.03"E			

NUMBER	LENGTH	RADIUS	LINE / CHORD DIRECTION	A VALUE
C2	12.252	41.130	SOUTH67° 56' 21.29"WEST	71 771232
C3	7.333	21.295	SOUTH69° 16' 11.68"WEST	
C3	4.657	21,295	SOUTH72° 52' 11.85"WEST	
C5	6.259	21.295		
			SOUTH58° 11' 06.33"WEST	
C6	3.307	21.295	SOUTH54° 12' 50.29"WEST	
C7	6.537	21.295	SOUTH49° 52' 07.14"WEST	
C8	7.281	21.295	SOUTH50° 52' 08.83"WEST	
C9	10.077	12.162	SOUTH36° 55' 42.18"WEST	
C10	6.405	8.063	SOUTH35° 56' 55.12"WEST	
C11	3.056	6.310	SOUTH72° 34' 44.47"WEST	
C12	14.922	19.995	NORTH72° 10' 00.19"WEST	
L2	13.613		S76° 28' 23.57"W	
L3	5.555		S59° 24' 19.01"W	
L4	8.941		S79° 08' 04.35"W	
L5	11.152		S66° 36' 19.34"W	
L6	16.212		S49° 45' 53.31"W	
L7	11.978		S58° 39' 47.27"W	
L8	64.823		S41° 04' 27.02"W	
L9	89.366		S60° 39' 50.64"W	
L10	10.297		S13° 11' 33.71"W	
L11	7.309		S58° 42' 16.52"W	
L12	6.722		S86° 27' 12.43"W	
L13	10.526		N50° 47' 12.81"W	

PRECAST REINFORCED CONCRETE

SPLIT CULVERT LOCATION

COORDINATES

201981.1291

1334856.6176

202033.8410

1334902.9036

202071.5999

1334968.6945

START NORTHING

START EASTING

MIDPOINT NORTHING

MIDPOINT EASTING

END NORTHING

END EASTING

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AIRCRAFT CREEK
ERT REPLACEMEN

SUED

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DESIGNED BY: DKE


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SHEET CONTENTS
SITE PLAN

SHEET NO. 3 of 10



GENERAL NOTES

- 1. EROSION CONTROL BMP'S AS SHOWN ARE THE MINIMUM REQUIRED TO BEGIN CONSTRUCTION. ADDITIONAL BMP'S SHALL BE IMPLEMENTED AS NEEDED TO PREVENT TRANSPORT OF SEDIMENT FROM THE SITE.
- 2. PROVIDE DUST CONTROL BY WATERING WHEN NEEDED OR AS DIRECTED BY CITY INSPECTOR.
- 3. STABILIZE BARE EARTH AREAS THAT ARE NOT WORKED WITH FINAL LANDSCAPING OR TEMPORARY MULCHING/COVER AS REQUIRED BY CITY INSPECTOR.
- 4. FINAL GRADE CONTOURS ARE SHOWN FOR REFERENCE ONLY.
- 5. GRADING FOR THIS PROJECT INCLUDES FILLING OF THE EXISTING STREAM CHANNEL WHERE SHOWN, EXCAVATION OF THE NEW STREAM CHANNEL AS SHOWN, AND FILLING OVER THE NEW CULVERT. FUTURE GRADING ON SITE TO BE PERFORMED BY A SEPARATE RIVA TOWNHOME PROJECT.
- 6. SEE SHEET G-002 FOR STANDARD TESC PLAN NOTES FOR CITY

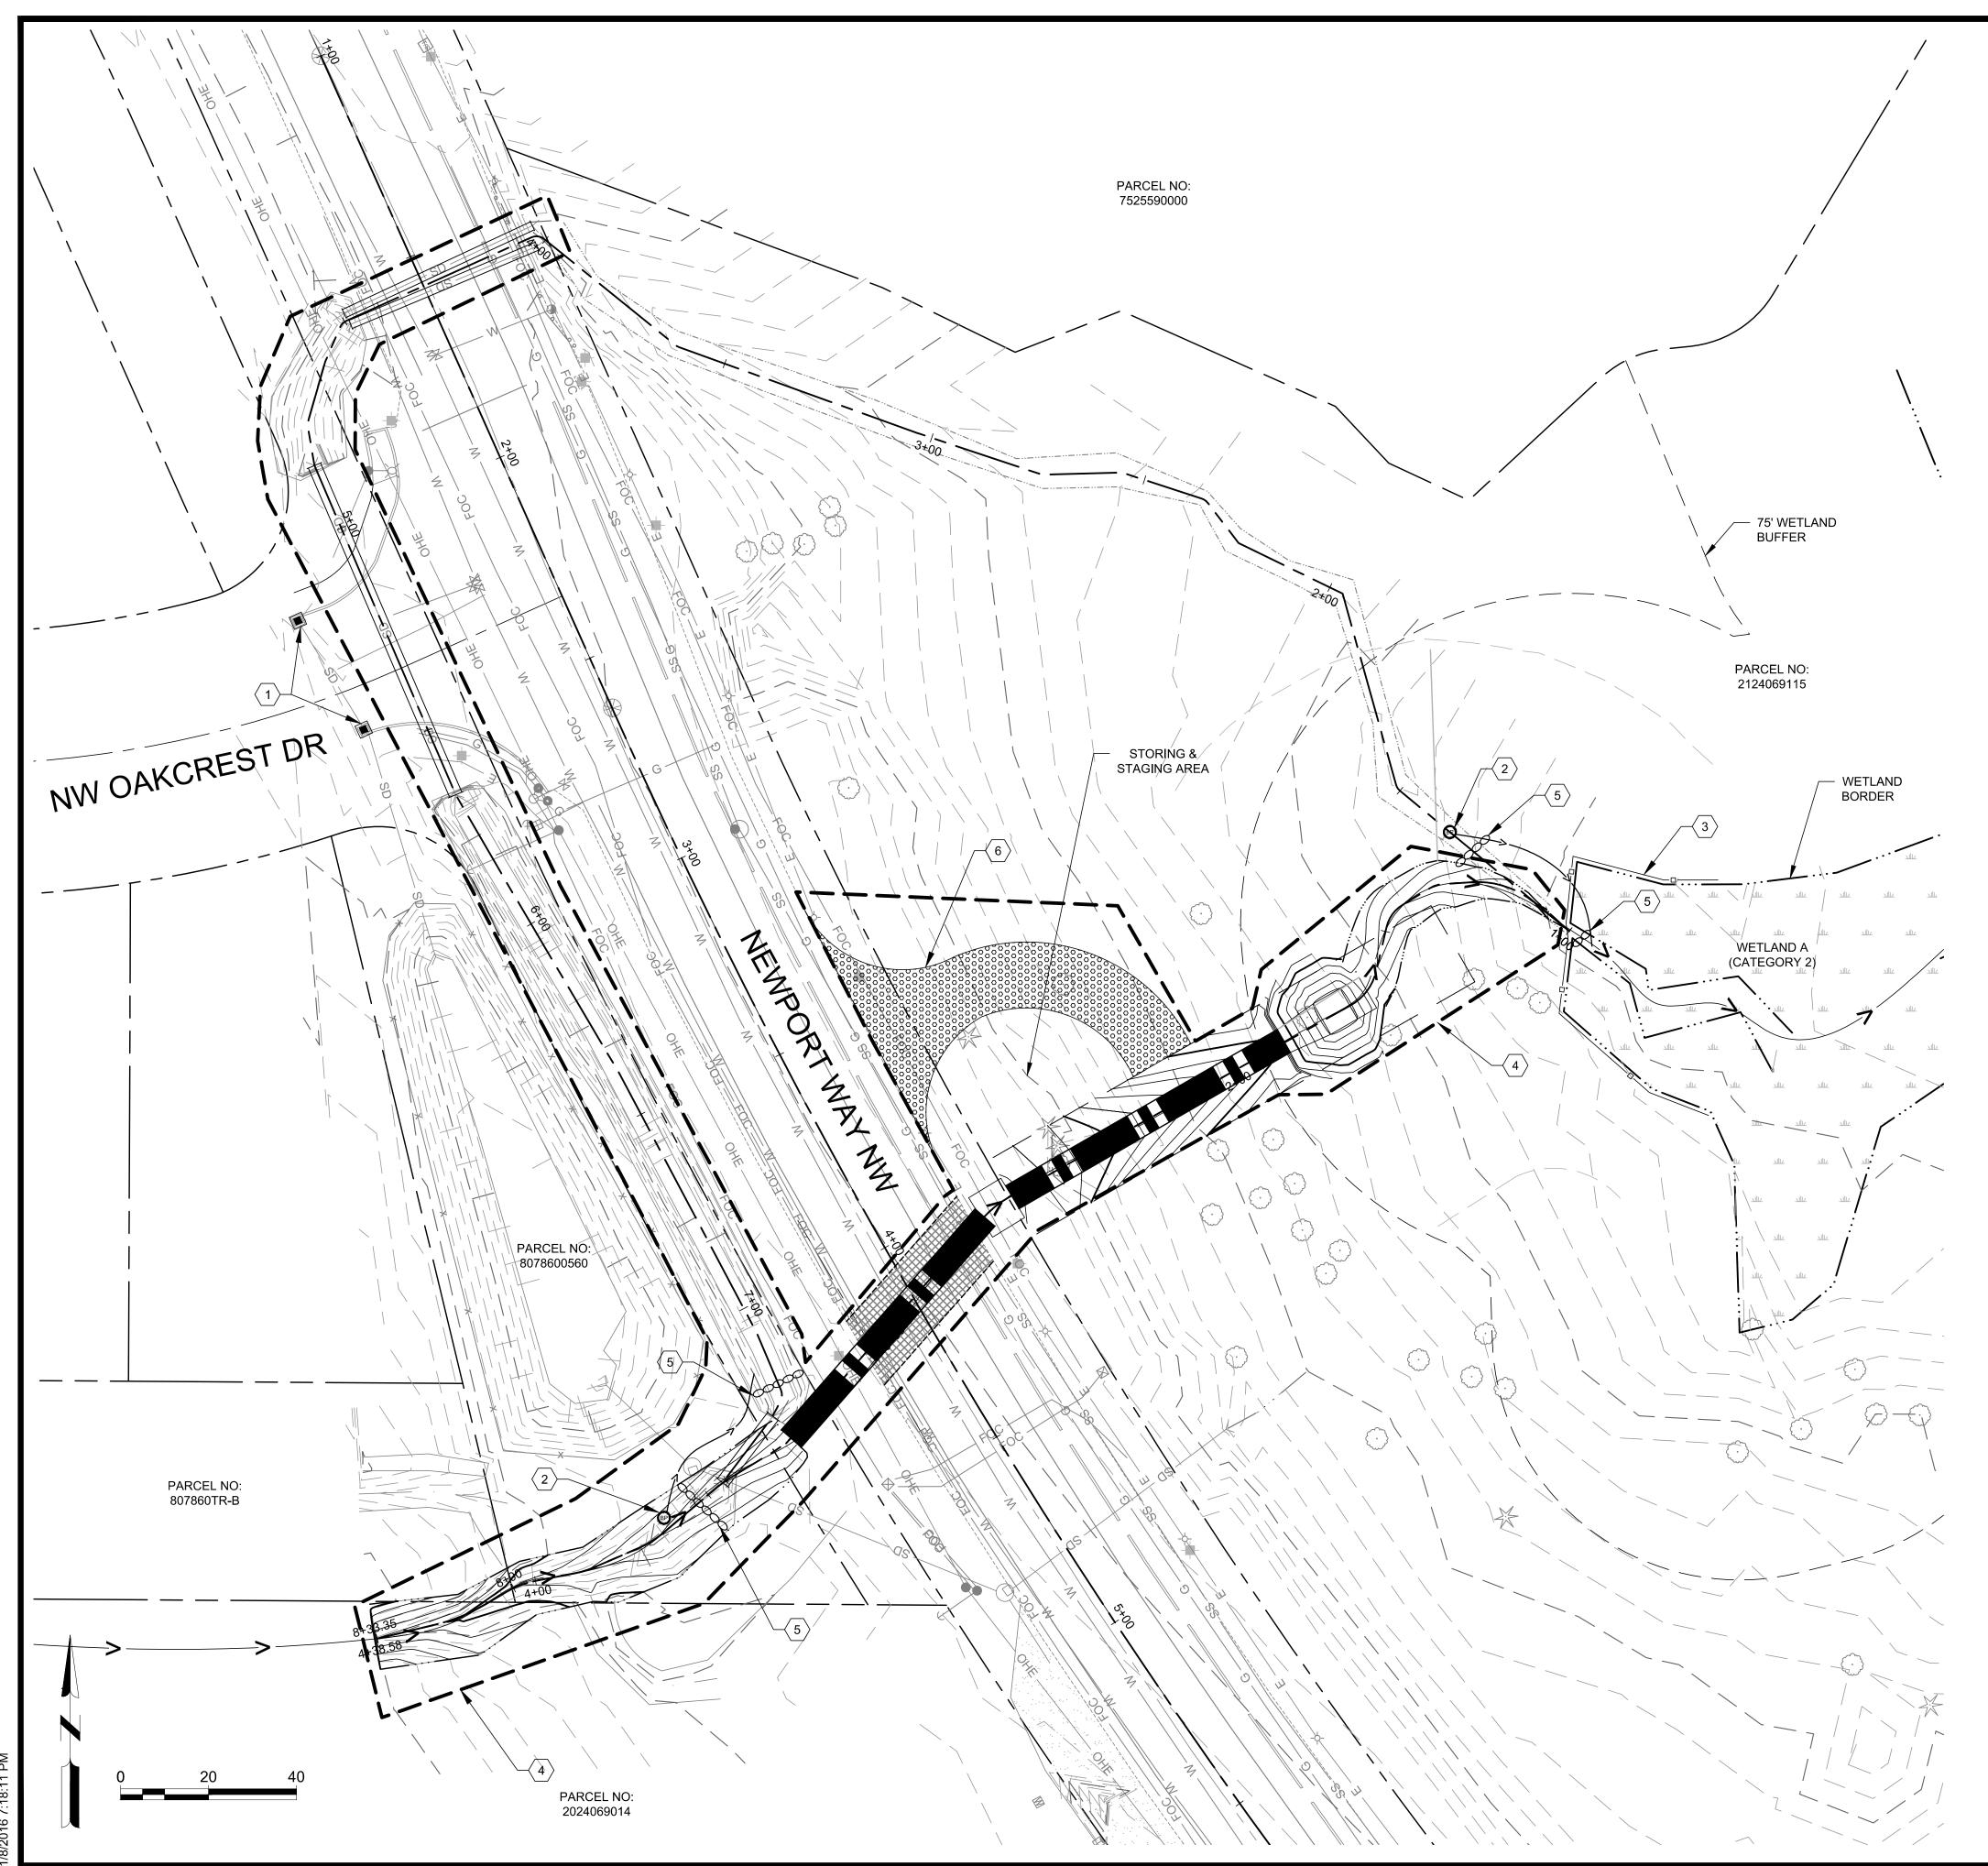EROSION CONTROL LEGEND

CLEARING LIMIT

SAWCUT LINE

HIGH VISIBILITY FENCE

INLET PROTECTION (EXISTING CATCH BASIN)

SANDBAG DIVERSION DAM

DIVERSION PUMP

TEMPORARY CONSTRUCTION ENTRANCE

EROSION CONTROL KEYED NOTES

- 1 INLET PROTECTION (EXIST. CATCH BASIN)
- DIVERSION PUMP (DIVERT FLOWING WATER DOWNSTREAM AROUND CONSTRUCTION AREA IF WATER IS PRESENT)
- (3) HIGH VISIBILITY SILT FENCE
- 4 CLEARING LIMITS
- 5 SANDBAG DIVERSION DAM
- 6 TEMPORARY CONSTRUCTION ENTRANCE

CONSTRUCTION SEQUENCE

- 1. PRE-CONSTRUCTION MEETING.
- 2. FLAG/MARK CLEARING LIMITS IN FIELD (BY SURVEYOR) AND ARRANGE INSPECTION BY CITY AND PROJECT ARBORIST PRIOR TO ANY CLEARING, GRUBBING, AND EARTHWORK.
- 3. POST SIGN WITH NAME AND PHONE NUMBER OF TESC SUPERVISOR.
- 4. INSTALL PERIMETER PROTECTION (SILT FENCE, WATTLES, ETC.)
- 5. INSTALL CONSTRUCTION ENTRANCE.
- 6. INSTALL BYPASS PUMP SCHEME SO THAT ANTI-AIRCRAFT CREEK CAN UTILIZE THE EXISTING CHANNEL AND BYPASS ALL CONSTRUCTION ACTIVITIES.
- 7. SAWCUT AND INSTALL THE NEW CULVERT CROSSING NEWPORT WAY NW IN ACCORDANCE WITH THE CITY OF ISSAQUAH STANDARDS AND MANUFACTURER'S RECOMMENDATION.
- REMOVE THE FURTHEST UPSTREAM CULVERT PER SHEET C-301 ACCORDING TO THE CITY OF ISSAQUAH STANDARDS
- 9. FINISH INSTALLATION OF CULVERT AND PROPOSED STREAM CHANNEL BEFORE REMOVING BYPASS PUMPS.
- 10. ABANDON THE EXISTING CULVERTS PER THE DEMOLITION PLAN ON SHEET C-301 AND FILL
- ABANDONED CHANNELS.
- 11. MAINTAIN EROSION CONTROL MEASURES IN ACCORDANCE WITH THE CITY OF ISSAQUAH STANDARDS AND MANUFACTURER'S RECOMMENDATION.
- 12. RELOCATE EROSION CONTROL MEASURES OR INSTALL NEW MEASURES SO THAT AS SITE CONDITIONS CHANGE, THE EROSION AND SEDIMENT CONTROL IS ALWAYS IN ACCORDANCE WITH THE CITY OF ISSAQUAH TESC MINIMUM REQUIREMENTS.
- 13. DISTURBED AREAS TO BE REVEGETATED WITH NATIVE PLANTS PER CITY OF ISSAQUAH

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ANTI-AIRCRAFT CREEK
CULVERT REPLACEMEN

NOT FOR CONSTRUCTION

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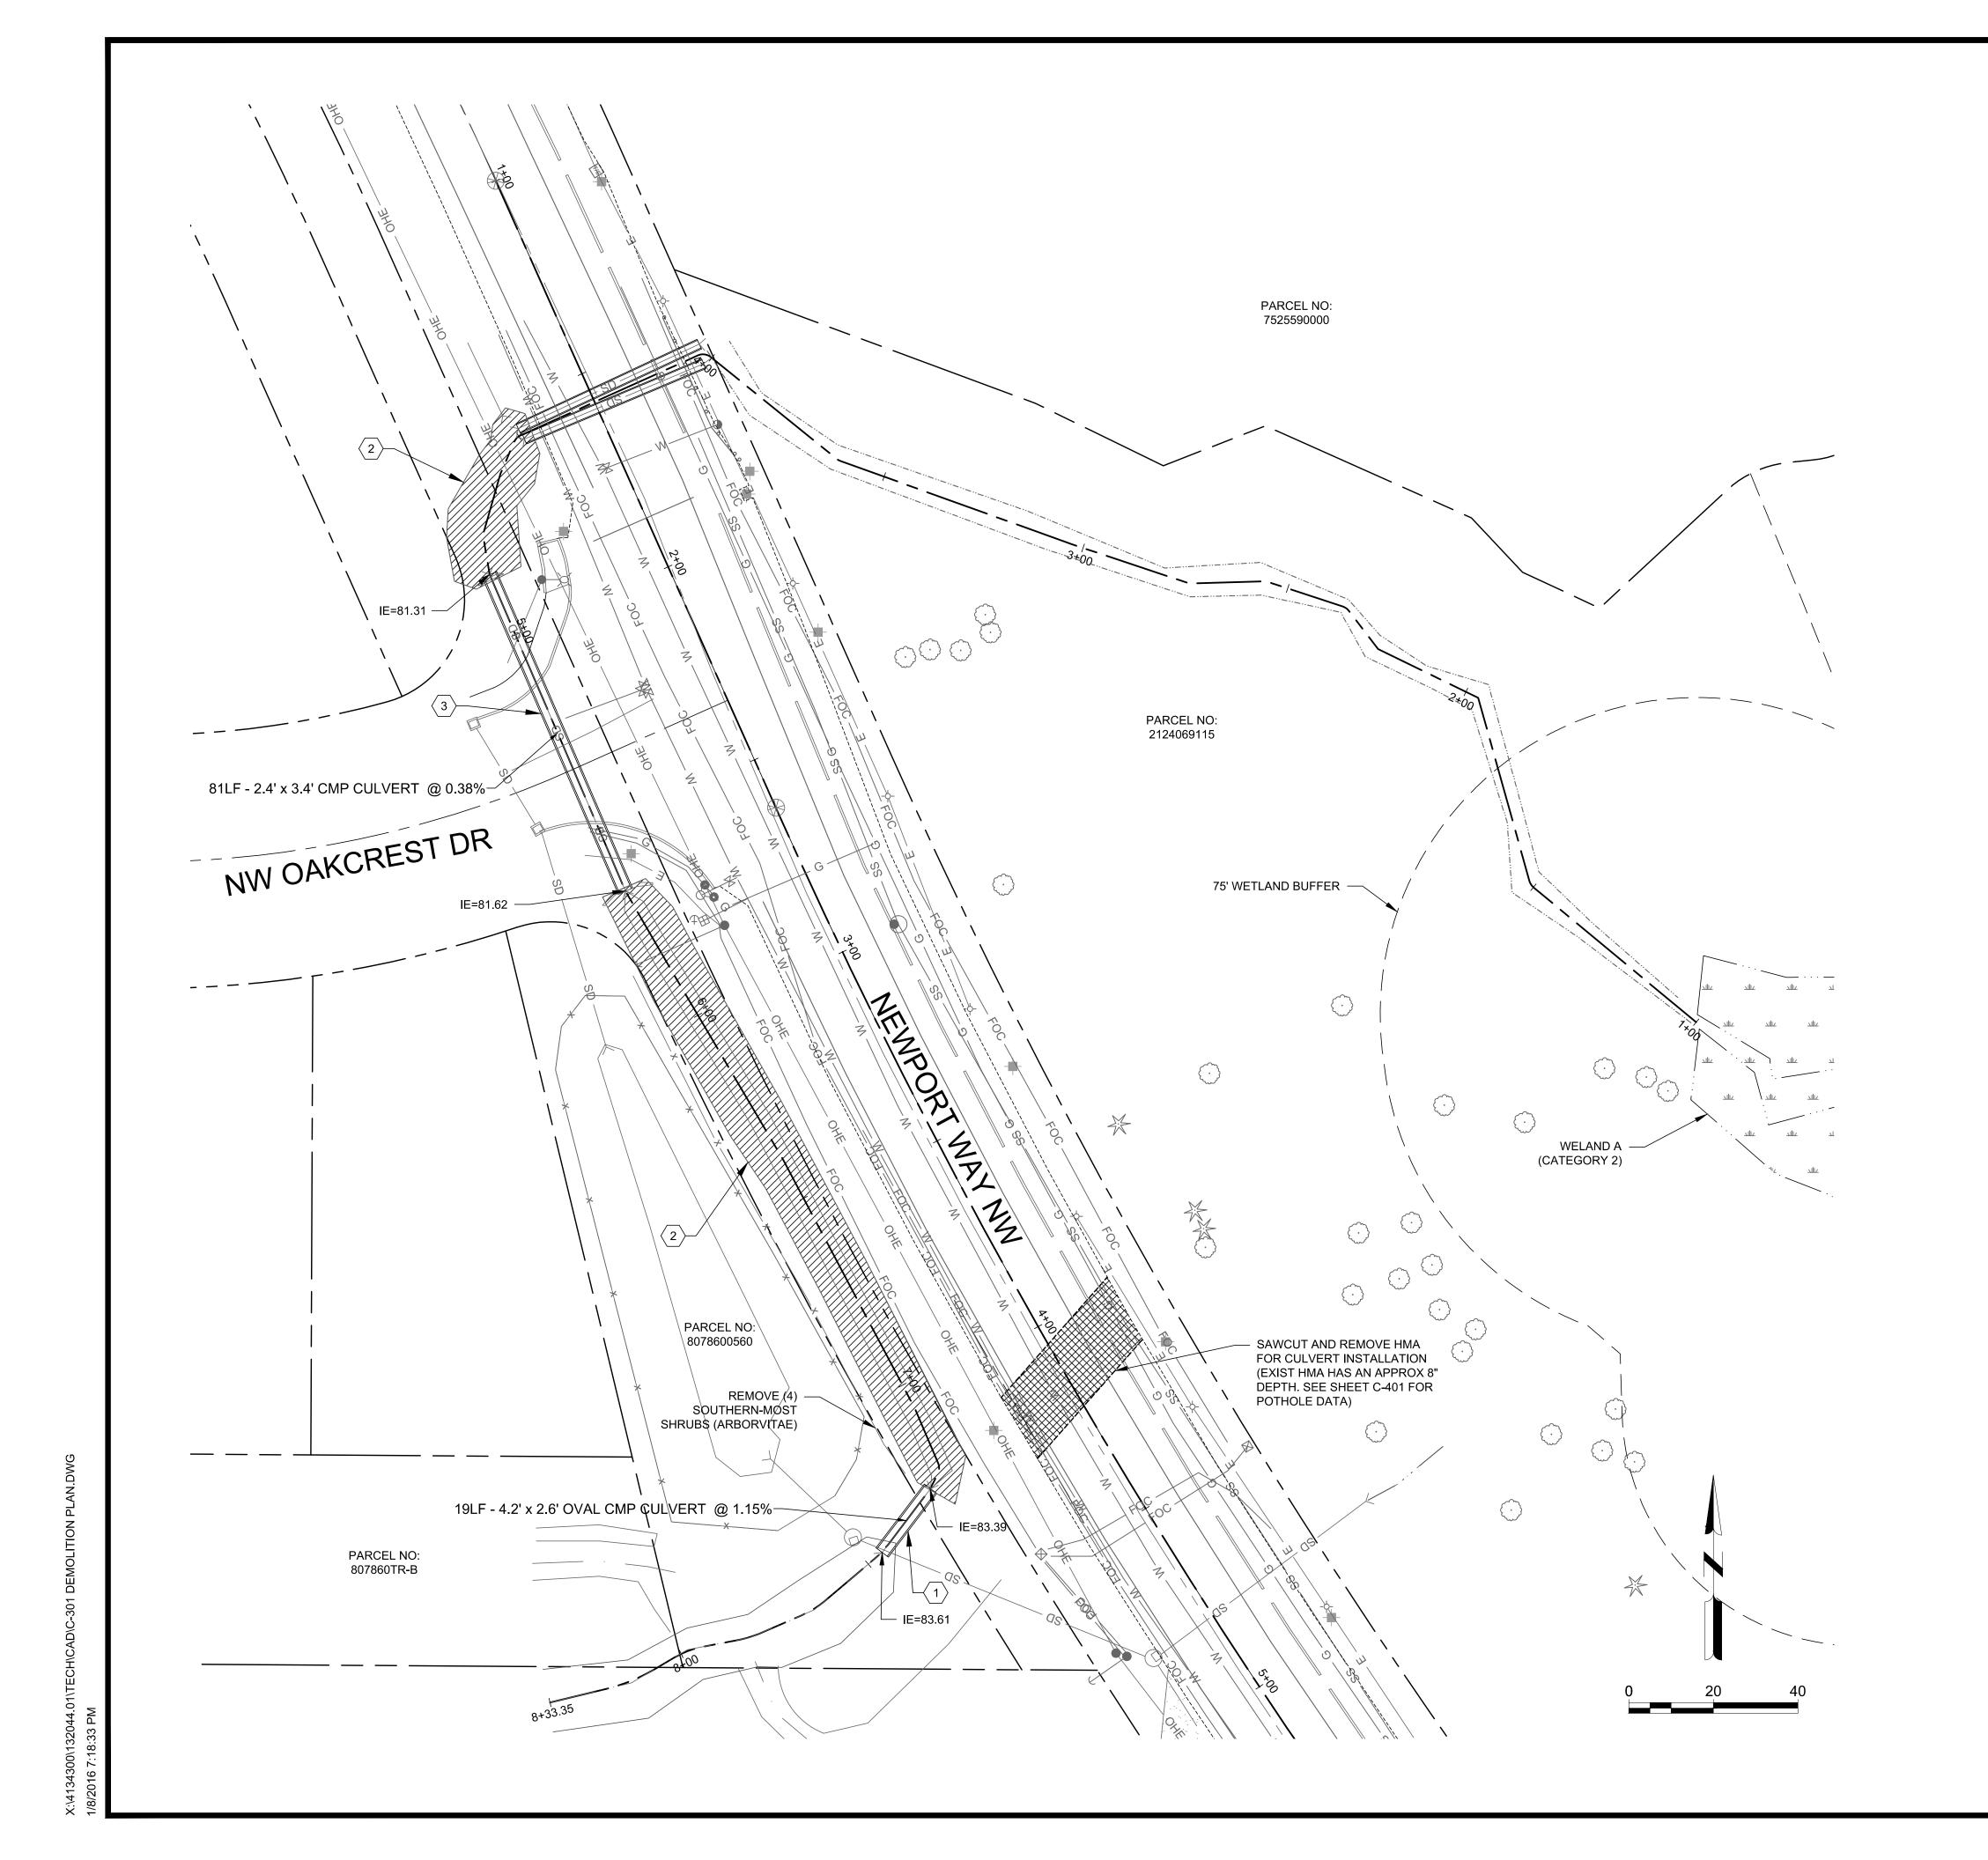
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SHEET CONTENTS

TEMPORARY EROSION AND SEDIMENT CONTROL

SHEET NO. 4 of 10



LEGEND

POWER/UTILITY POLE TRAFFIC SIGNAL BOX LUMINAIRE **GUY ANCHOR** AREA LIGHT BOLLARD WATER VALVE WATER METER FIRE HYDRANT HOSE BIB COMMUNICATION PEDESTAL TRAFFIC SIGN SANITARY SEWER LINE WATER LINE STORM DRAIN LINE OVERHEAD POWER LINE COMMUNICATION/FIBER OPTIC LINE GUARD RAIL UNDERGROUND POWER ---- SAWCUT LINE STREAM FILL WETLAND HMA REMOVAL

DEMOLITION KEYED NOTES

- REMOVE EXISTING CULVERT
- FILL EXISTING STREAM CHANNEL WITH SURPLUS EXCAVATION MATERIAL
- ABANDON EXISTING CULVERT (FILL ENTIRELY WITH CDF)

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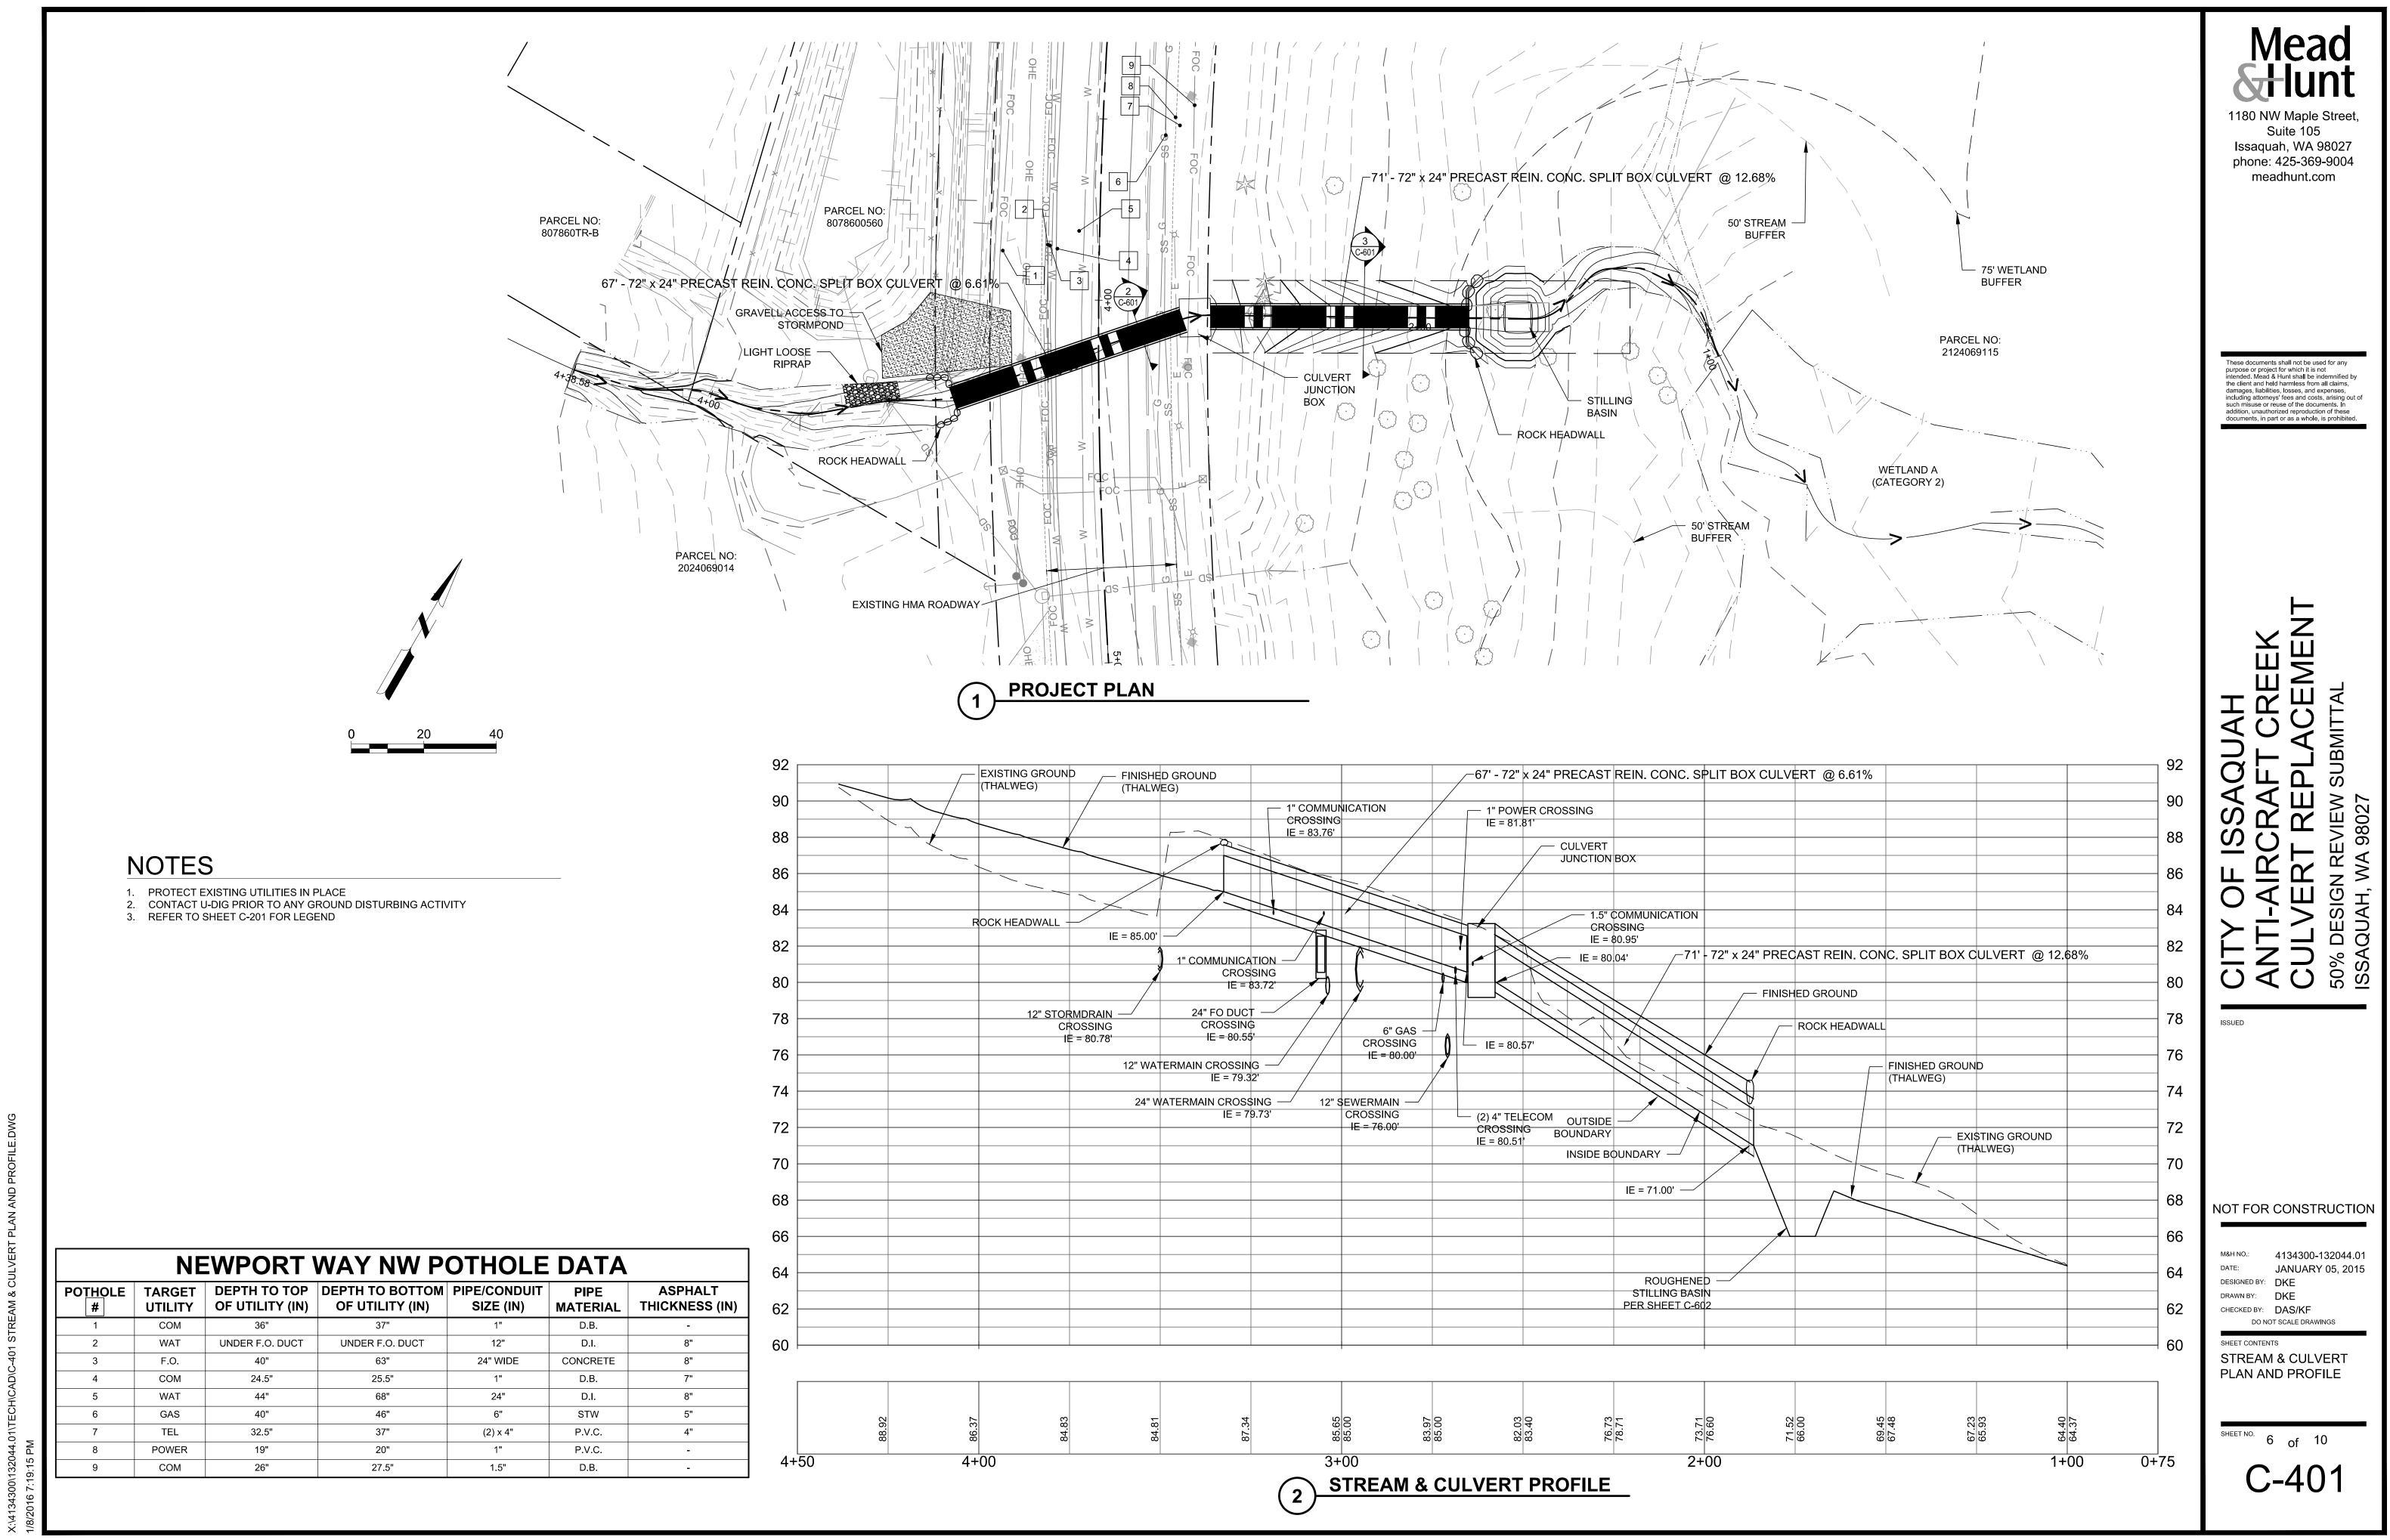
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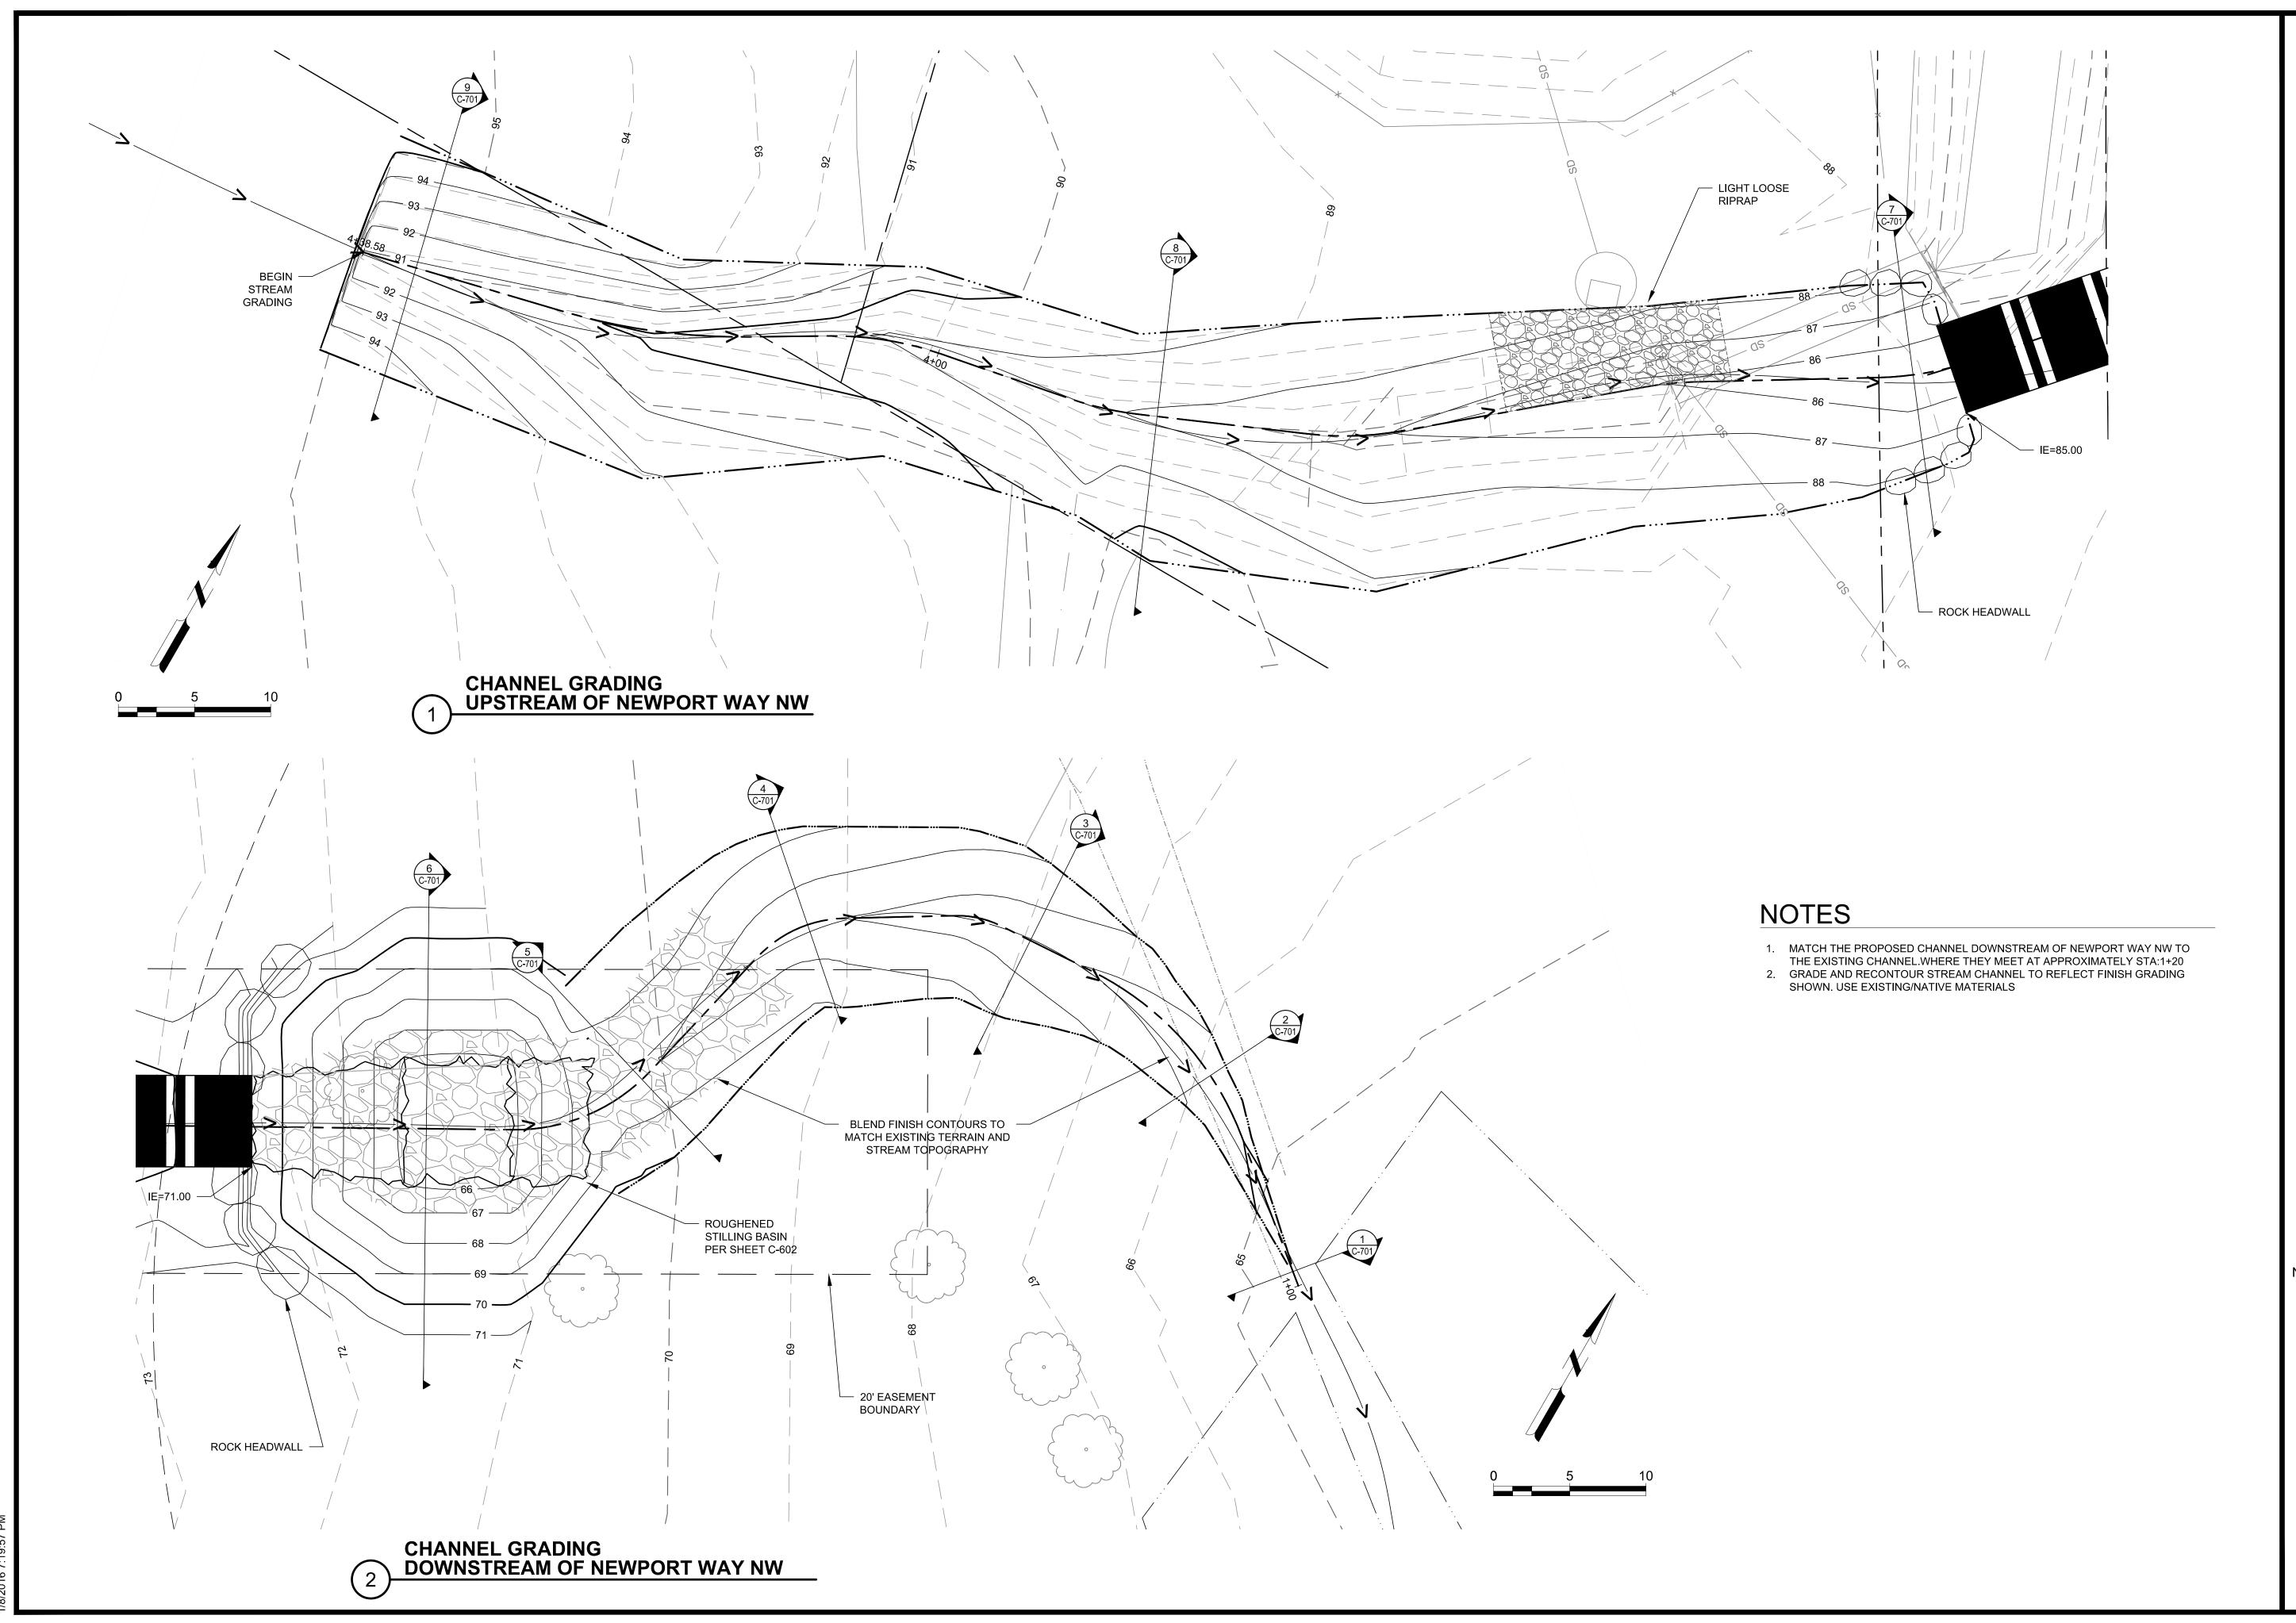
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SHEET CONTENTS DEMOLITION PLAN

SHEET NO. 5 of 10





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ANTI-AIRCRAFT CREEP
CULVERT REPLACEME
50% DESIGN REVIEW SUBMITTAL

NOT FOR CONSTRUCTION

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DATE: JANUARY 05, 2015

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SHEET CONTENTS
STREAM CHANNEL
GRADING


SHEET NO. 7 of 1

CULVERT IN ROADWAY SECTION VIEW

COMMON BORROW — 7' - 4" PRECAST REINFORCED -CONCRETE SPLIT BOX CULVERT CONTROLLED -DENSITY FILL GRAVEL BACKFILL CLASS A

CULVERT IN NATURAL MATERIAL SECTION VIEW

SCALE: 1" = 2'

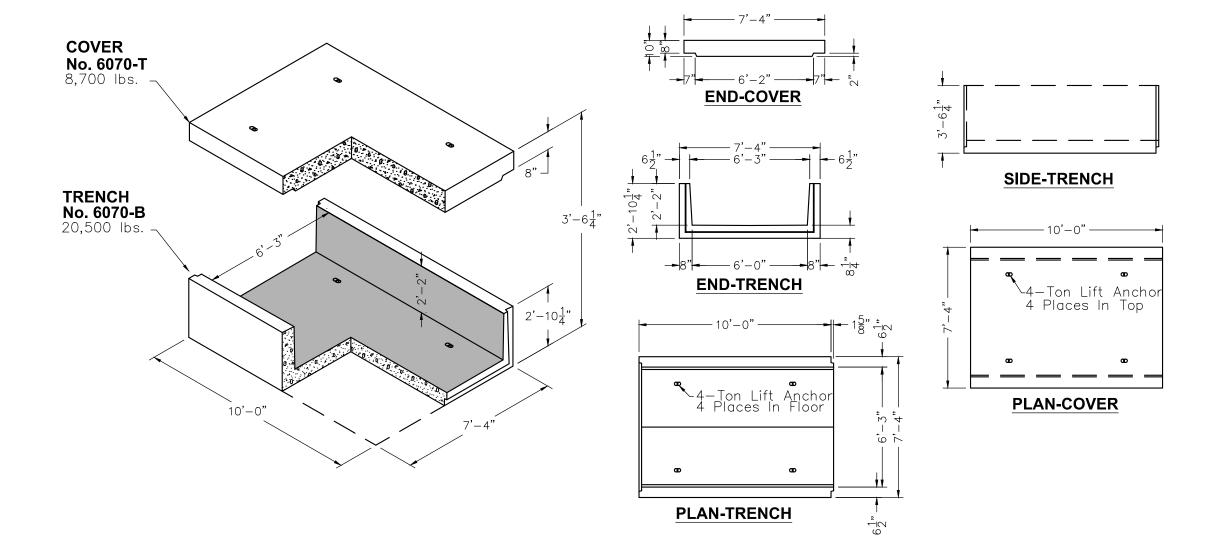

PRECAST REINFORCED CONCRETE SPLIT BOX CULVERT

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SHEET CONTENTS **CULVERT DETAIL** SHEET 1

SHEET NO. 8 of 10

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TRENCH WIDTH VARIES

WIDTH OF GRIND OR SAWCUT

TOTAL PATCH DEPTH
EXISTING MATT THICKNESS PLUS

1" UP TO 7" (MIN. OF 3")
DETERMINED BY CITY ENGINEER.

- SEE TRENCH DETAIL T-50

Back to Table of Contents

PATCHING FLEXIBLE PAVEMENTS

TRANSVERSE OR SQUARE CUTS

NOTE: THE ORIGINAL IS SIGNED BY THE ENGINEER, APPROVED FOR PUBLICATION AND FILED A

PLAN VIEW TRANSVERSE CUT

SURFACING

- EXCAVATED AREA

CROSS SECTION OF TRANSVERSE OR SQUARE CUT

NOTES:

1. ALL TRENCHES SHALL BE BACKFILLED AND PATCHED WITH TEMPORARY ASPHALT OR COVERED WITH STEEL PLATES AND SPIKED IN PLACE AT THE END OF EACH WORK DAY. PLATES SHALL BE REMOVED WITHIN 3 DAYS. 12" ASPHALT TAPER UP TO PLATE. PROVIDE APPROPRIATE SIGNAGE.

TEMPORARY PATCHES SHALL BE PLACED AT A MINIMUM 6" DEPTH, AND MAINTAINED AS NEEDED FOR A SMOOTH SURFACE.

3. ALL TEMPORARY PATCHES SHALL BE PERMANENTLY PATCHED WITHIN TWO (2) WEEKS.
4. PATCHES WITHIN 25' OF EACH OTHER REQUIRE REPLACEMENT OF THE TOTAL AREA, INCLUDING THE AREA BETWEEN THE

ALL PAVEMENT MARKINGS SHALL BE REPLACED WITH MATERIALS SPECIFIED IN STANDARDS WITHIN 14 DAYS (DURASET

8. ALL PATCHES SHALL ABUT COMPETENT MATERIAL AS DIRECTED IN THE FIELD (MUST BE FLUSH).

10' WIDTH APPLIES TO ARTERIALS

OR TO LANE EDGE

IF CUT ENDS IN WHEEL PATH.

PLAN VIEW

SQUARE CUT

ISSAQUA H

PUBLIC WORKS DEPARTMENT

AUGUST 2010

АТВ

FACE OF CURB OR EDGE OF PAVEMENT

_CENTERLINE OR LANE LINE

FACE OF CURB OR

EDGE OF PAVEMENT

ISSUED

NO SCALE

STANDARD **DETAIL NO.**


T-48

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4134300-132044.01 DATE: JANUARY 05, 2015 DESIGNED BY: DKE

CHECKED BY: DAS/KF DO NOT SCALE DRAWINGS

SHEET CONTENTS **CULVERT DETAIL** SHEET 2



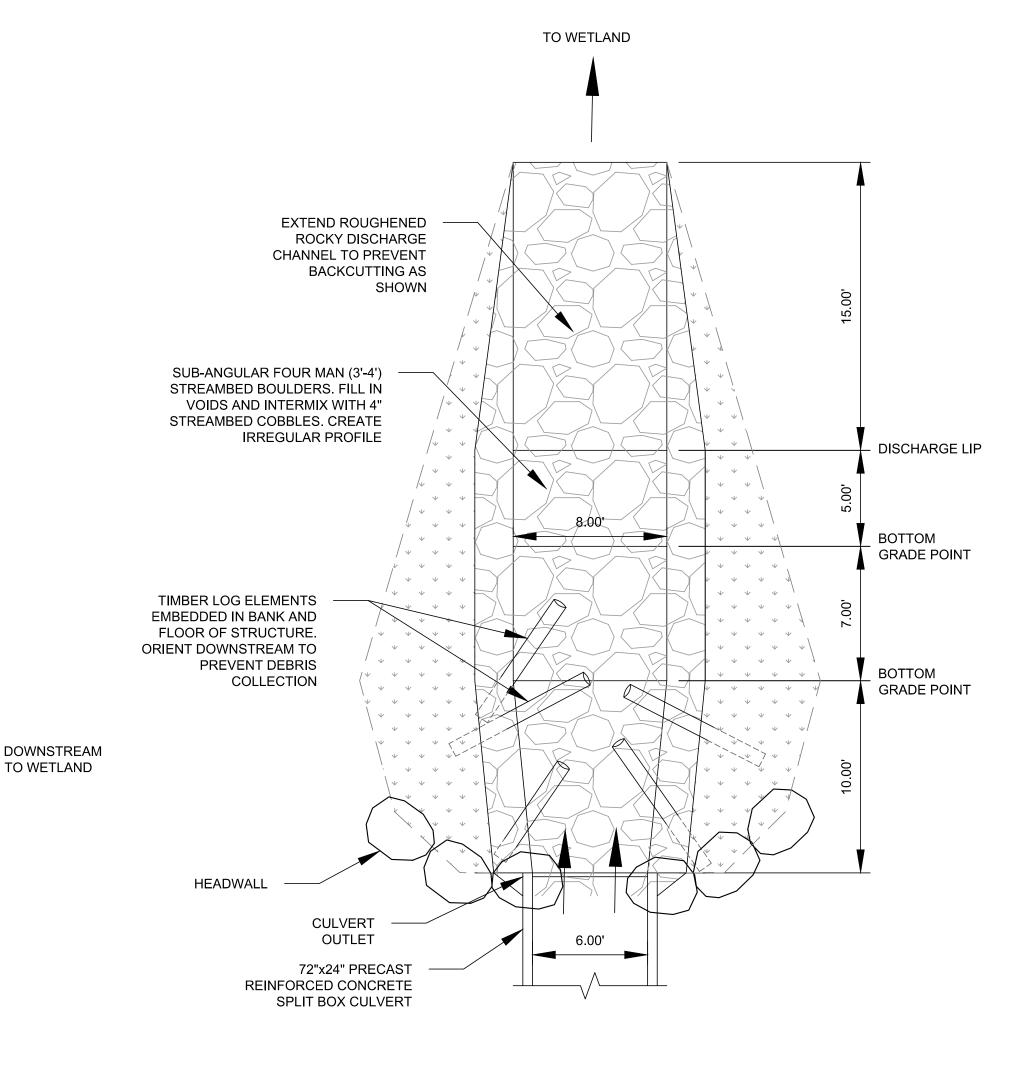



TIMBER LOG ELEMENTS

AS NOTED IN DETAIL 2

SUB-ANGULAR FOUR MAN (3'-4')

STREAMBED BOULDERS. FILL IN

VOIDS AND INTERMIX WITH 4"

STREAMBED COBBLES. CREATE

ROCK IE=68.5

TO WETLAND

IRREGULAR PROFILE

NOTES

72"x24" PRECAST

IE=71.0

SPLIT BOX CULVERT

REINFORCED CONCRETE


ROCK HEADWALL

- 1. THE ROUGHENED STILLING BASIN DESIGN WAS DESIGNED TO BE COMPARABLE TO USBR TYPE III STILLING BASIN DESIGN CRITERIA.
- 2. USE BLOCKY, SUB-ANGULAR BOULDERS SIZED D100 = 3 '- 4' AVG.
- DIAMETER.
- 3. USE WOODY DEBRIS PLACED ANGULARLY DOWNSTREAM SIZED AT 12" MIN DIA. TO 18" DIA. BY 20'-25' LONG. EMBED HALF LENGTH.

CHANNEL CROSS SECTION STATION: 1+01.00


HORIZ. SCALE: 1" = 10' VERT. SCALE: 1" = 5'

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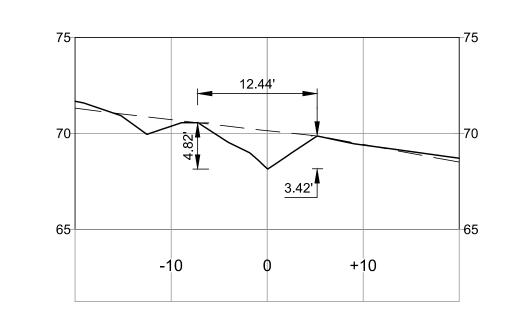
CHANNEL CROSS SECTION STATION: 1+45.00

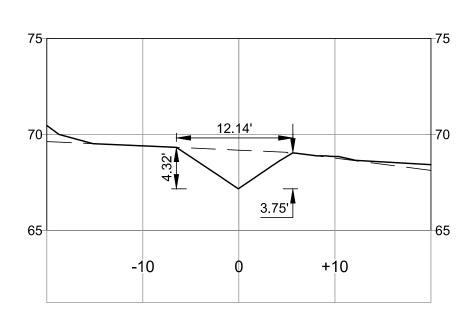CHANNEL CROSS SECTION STATION: 3+35.00




CHANNEL CROSS SECTION STATION: 1+15.00

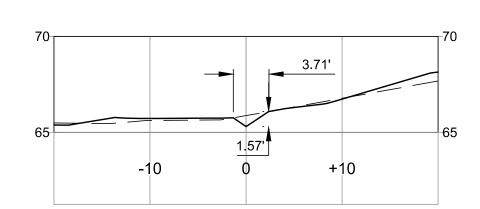HORIZ. SCALE: 1" = 10' VERT. SCALE: 1" = 5'




CHANNEL CROSS SECTION STATION: 1+60.00

HORIZ. SCALE: 1" = 10' VERT. SCALE: 1" = 5'

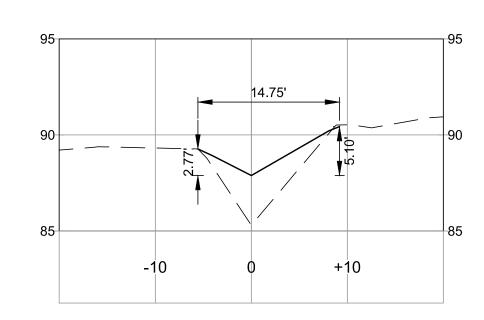


CHANNEL CROSS SECTION STATION: 3+85.00

HORIZ. SCALE: 1" = 10' VERT. SCALE: 1" = 5'

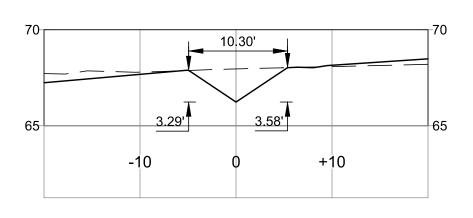


CHANNEL CROSS SECTION STATION: 1+30.00

HORIZ. SCALE: 1" = 10' VERT. SCALE: 1" = 5'

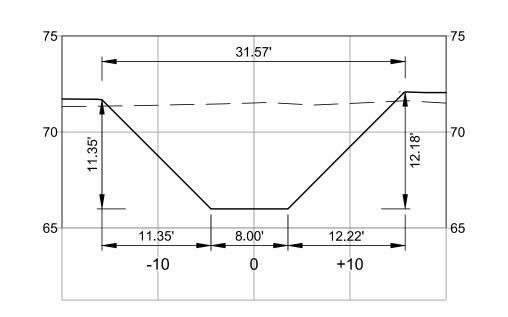

CHANNEL CROSS SECTION STATION: 1+75.00 (STILLING BASIN) HORIZ. SCALE: 1" = 10' VERT. SCALE: 1" = 5'

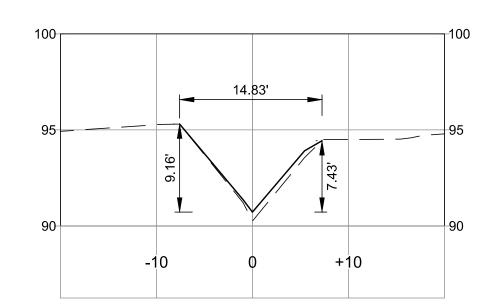


CHANNEL CROSS SECTION STATION: 4+35.00 HORIZ. SCALE: 1" = 10' VERT. SCALE: 1" = 5'

LEGEND

— — EXISTING GROUND

PROPOSED FINISHED GROUND

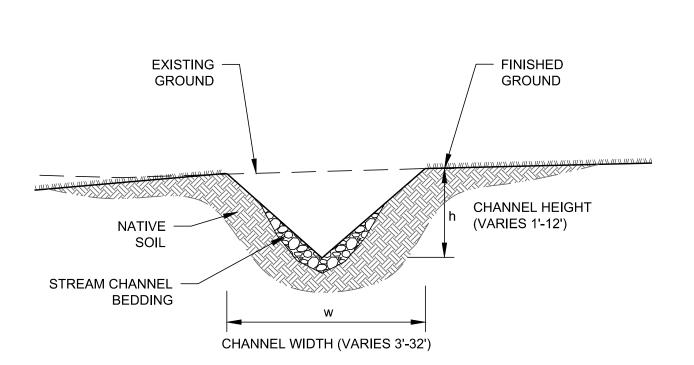

CHANNEL CROSS SECTION TYPICAL

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SHEET CONTENTS STREAM CHANNEL **CROSS SECTIONS**

SHEET NO. 10 of 10